

ROOM SCHEDULE					
ROOM SF LIGHT					
BEDROOM 2	155 SF	21.2	11.1		
BEDROOM 3	155 SF	18.5			
BATH 2	85 SF	10.4	14.1		
		10.4	5.5		

*EGRESS IN NH = MIN. 5.7 SF OPENING 20W X 24H

	1 -			OF CITE	ANACE SOM	X 24	H	*	_
	MANUF.	ID.	WIN	DOW SC	HEDULE				7
	PELLA	A3325	ITHE	RO HIDTH	RO HEIGHT	_	ECOPOR		l
	PELLA		10 44446	2'-9 3/4	2'-1 3/4"	4	_	REMARKS	l
	PELLA		DOUBLE HUNG	- 137	4'-9 3/4'	-	NO NO		ı
Ī	PELLA		DOUG HONG		4'-5 3/4'				
		5.13737	DOUBLE HUNG	3'-1 3/4"	4'-9 3/4'	-	YES	TEMPERED	
- 1	NO. ID	FS/ DIDT	<u></u>				153		

SECOND LEVEL FLOOR PLAN SCALE: 1/4" = 1'-0" CEILING HEIGHT = 8'-0"

7'-2"

DH3757

10'-9 3/4" -6.25" THICK ICYNENE INSULATED EXTERIOR WALLS MOD. 'C'.

BEDROOM 2 CARPET BY BLDR.

155 5F (13'-2" x 12'-11")

STORAGE AREA

r-4'-10" KNEEWALL

-8'-0" CEILING

HEIGHT (TYP)

(TYP.)

ROOF

SLOPES

STEP DOWN

INTO STORAGE (4)2X4 SPP S#2

TYPE I POST (4)2X4 SPF-S#2_/

SO NO. DESCRIPTION			
REV'D PER PROF DATES	BY	DATE	T
3 REV'D PER PRRF DATED 6/20/13D	ML	6/14/13	1
3 REVID PER MARK-UP DATED 7/25/13	ML	6/24/13	
1723/13	D ML	7/25/13	
		 	

100

2

OUT OUT

P.O. BOX 235 PROJECT: KE, N.H. 03275 877-GO-EPOCH 603) 225-3907 BUILDER: BAILEY PARK PROP, LLC. 247 HAYDEN RD. HOLLIS, NH 03049 chhomes.com

4332-13 ENDBUYER: HILLCROFT SPEC. LOT 178-322-4, HILLCROFT RD. DRAWN BY: ML LACONIA, NH 03246 SCALE: AS NOTE

NUMBER:

38'-0"

9'-7"

BATH 2 TILE BY BLDR. 50 85 SF (9'-9" x 9'-2")

HALL 2 HOWD. BY BLDR.

-RAILINGS BY

BLDR.

C 2CB-1:(2)1-3/4"XI6" LVL
W/(1) 3/4" STEEL FLITCH PLATE

38'-0"

DH3753-T

11'-10"

8

2/6

Ω

CATHEDRAL CEILING-OPEN TO BELOW.

BEDROOM 3 CARPET BY BLDR.

155 SF (13'-2" x 12'-11")

W (1)1/2" STEEL FLITCH PLATE

CEILING SLOPES -LOFT OPTION:

FRAME FOR FUTURE 8'-0" WIDE OPENING.

-17'-6" CEILING HEIGHT A.S.F OF FIRST LEVEL

42" SILL HEIGHT

81.5" HEAD HEIGHT

7'-2"

12'-10 EADER 5'-0"

8'-5

WNDW HEADER HEIGHT TO MATCH OTHER WNDWS THIS GABLE END

TYPE 3 POST— (2)2X6SPF-S#2 (DOUBLE JACK)

TYPE 3 POST (2)2X6SPF-S#2-

DH3757


10'-9 3/4"

11'-10"

SHEET TITLE: SECOND LEVEL FLOOR PLAN DATE: 6/11/13 SCALE: AS NOTED

SHEET NUMBER

EPOCNIONES fine custom modular from	P.O. BOX 235 PEMBROKE, N.H. 03275 1-877-GO-EPOCH (603) 225-3907 www.epochhomes.com ©2009 Epoch Homes

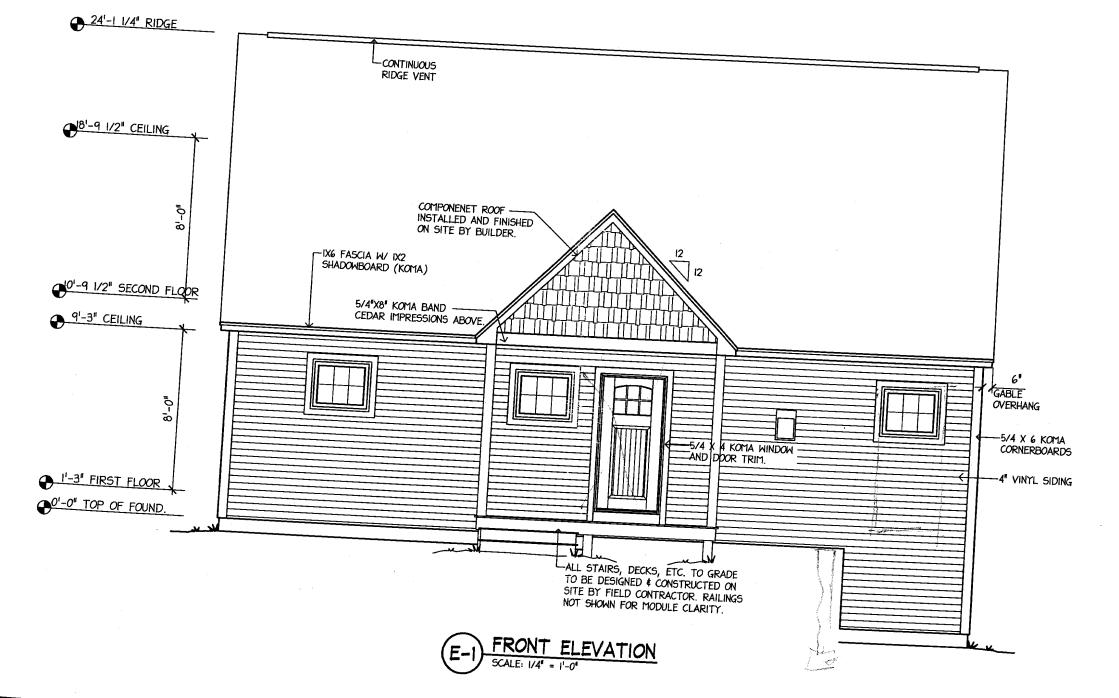

NO. DESCRIPTION 1 REV'D PER PRRF DATED 6/32/13D ML 6/14/13	
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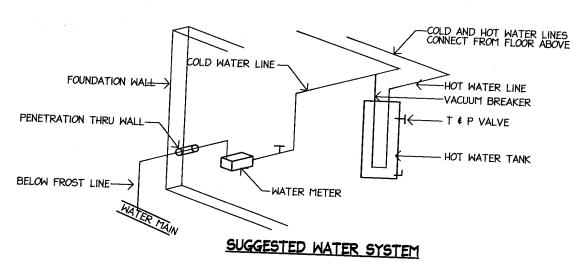
STA	ANDARD HEADER	SCHEDUI F
1	EXTERIOR OPENING	13 ¢ 14 WIDE
COLONIA	3'-2'	(2) 2x6 W/ (1) 2x10
		(2) 2x8 W/ (1) 2x10
F.R. OF	8'-2"	(3) 2x8 W (1) 2x10
ST P.	MARR.WALL OPENING	13 ¢ 14 WIDE
_∞	2'-6" TO 5'-6"	(2) 2x6 W/ (2) 2X12'S
L	6'-0" TO 8'-0"	(2) 2x8 W/ (2) 2XI2'5


STANDARD HEADER SCHEDULE						
	EXTERIOR OPENING	13 € 14 WIDE				
OR COLONIAL	3'-2"	(3) 2x6 SPF #2				
RANCH OR 2ND FLR. OF COL	6'-2"	(3) 2x6 SPF #2				
	8'-2"	(1) 2x6 \$ (2) 2x8 SPF #2				
	MARR.WALL OPENING	13 € 14 WIDE				
	2'-6" TO 5'-6"	(1) 2x6 SPF #2 PER MOD.				
	6'-0" TO 8'-0"	(1) 2x8 SPF #2 PER MOD.				

AREA	TENER SCHEL	FASTENI	GINEERING PAGES FOR ADDITION. ING REQUIREMENTS.	AL
ANLA	MATERIAL	GLUE	NAIL/STAPLE	
·	2x8 JST. TO 2x10 PERII	1. N/A		SPACING
FLOOR SYSTEM	2xI0 JST. TO 2xI2 PER	M. INA	12D	MIN. 4 PER BEAM
7.5	3/4 THE TO DECK	CONST. ADHESIVE	12D	MIN. 5 PER BEAM
_ v				4" ON EDGES/ 8" FIELD
	2x6 SILL PLT. TO PERIN	1. N/A	12D	I NAIL @ 3' O.C. TO JOIST
	2x6 STUDS TO SOLE	N/A	12D	I NAIL @ 6 O.C. TO BEAM
	1/2" SHEETROCK	CONST. ADHESIVE	16D	2 DIRECT NAIL
EXTERIOR WALLS	26 STUD TO TOP PLAT	E NA	#6 SCREWS OR BETTER	MIN. 24" O.C.
田子	DBL. TOP PLATE	N/A	0.131/31	3 DIRECT NAIL
동물	WALL TO FLOOR	INA	0.5123	1 0 18 O.C.
	JUNCT. POST TO WALLS	N/A	12D	1 0 16 O.C.
- 1	1/2 CDX PLYMOOD (GI)	CONST. ADHESIVE	8d	2 @ 16" O.C.
ŀ	EXT. APPLIED #1 # 2			4" ON EDGES/ 6" FIELD
- 1	V2 CDX PLYHOOD (G2)	CONST. ADHESIVE	84	
- H	INT/EXT. APPLIED # 1 4:	2	00	4 ON EDGES/ 6 FIELD
		N/A	DED MANUEL	
MALLS	2x STUDS TO PLATES WALL TO DECK	N/A	PER MANUFACTURER	PER MANUFACTURER
-3 ∺	12 SHEETROCK	N/A	16D	2 DIRECT NAIL
	AS STUDE TO BE	CONST. ADHESIVE		2 @ 16" O.C.
MALLS WALLS	X3 STUDS TO PLATES V8" CDX PLYWOOD	N/A	#6 SCREWS OR BETTER	4' ON EDGES/ 8" FIELD
₹₹Ľ	IALL TO DECK	CONST. ADHESIVE	IGGA GALV. STAPLE	2 DIRECT NAIL
~ ~ 17	2 SHEETROCK	N/A	IGD STAPLE	4" ON EDGES/ 8" FIELD
	G OP 24 DATE	CONST. ADHESIVE	#6 SCREWS OR BETTER	2 € 16" O.C.
SYSTEM STATE	KG OR 2x8 RAFTERS	N/A	16D	MIN. 24" O.C.
S & 1	PHALT SHINGLES	NA	84	3 € HEEL JOINT
in 1	VIEWTRUSS TO PLATE	N/A	I 1/4" MIN. GALV. WIRE STAPLE	4 • EDGES/ 8 • FIELD

1. CAPACITY HAS BEEN REDUCED FOR FRAMING SPECIFIC GRAVITY ACCORDING TO SDPINS T4.3A NOTE 3 AND IBC T2306.3 NOTE 4.

2. SHEAR CAPACITY FOR CURRENT DESIGN HAS BEEN INCREASED TO THE VALUE FOR SU SHEATHING WITH SAME NAILING BECAUSE STUD SPACING IS 16" MAX. OR PANEL ORIENTATION IS HORIZONTAL, SEE SDPINS T4.3A NOTE 2. AND IBC T2306.3 NOTE 4.



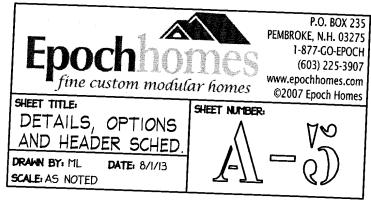

- 1. THE DEALER IS RESPONSIBLE TO CHECK ALL GOVERNING CODES CONCERNING HIS MODULES AND NOTIFY EPOCH CORPORATION OF ANY REQUIRED CHANGES FROM EPOCH'S STANDARD MATERIALS AND/OR CONSTRUCTION BEFORE BUILDING BEGINS.
- 2. THE DEALER IS RESPONSIBLE TO NOTIFY EPOCH OF ALL CHANGES THAT MAY OCCUR FROM THE ORIGINAL ORDER (2) TWO WEEKS BEFORE CONSTRUCTION BEGINS.
- 3. THE FIELD CONTRACTOR OR DEALER IS RESPONSIBLE TO NOTIFY EPOCH CORPORATION WHEN THE FOUNDATION IS READY FOR DELIVERY AND SETTING OF THE MODULES. NOTIFICATION ASSURES EPOCH THAT ALL SILLS ARE LEVEL AND SQUARE, KNEEWALLS, SILLSEALER, AND/OR ANY OTHER MATERIALS ARE BRACED AS REQUIRED AND MEET
- 4. THE FIELD CONTRACTOR OR DEALER IS RESPONSIBLE FOR ALL ZONING REGULATIONS INCLUDING SETBACKS AND LOT APPROVALS PRIOR TO MODULES BEING SET. THE FIELD CONTRACTOR OR DEALER IS RESPONSIBLE TO ASSURE EPOCH CORPORATION THAT ALL ROUTES TO THE SITE MEET ALL THE TRANSPORTATION REQUIREMENTS, THE FOUNDATION IS BACKFILLED, AND THE SITE MEETS ALL REQUIREMENTS. (SEE SITE PREPARATION DRAWING)
- 5. THE FIELD CONTRACTOR IS RESPONSIBLE TO SUPPLY AND INSTALL THE FOLLOWING MATERIALS:
- A. BALANCE OF MATERIALS NEEDED TO COMPLETE ALL THE PLUMBING HOOK-UPS TO THE WATER AND SEPTIC/SEWERAGE SYSTEM BELOW THE FIRST FLOOR.
- B. BALANCE OF MATERIALS NEEDED TO COMPLETE ALL ELECTRICAL REQUIREMENTS IN THE BASEMENT AND TO HOOK UP MAIN PANEL TO THE POWER SOURCE.
- C. ALL ADDITIONAL MATERIALS NEEDED TO COMPLETE THE BASEMENT AND FOUNDATION, BULKHEAD, SUMP PUMP, DOORS, WINDOWS, ETC.
- D. PERMANENT LALLY COLUMNS ARE REQUIRED TO BE SET WITHIN (3) THREE DAYS OF DELIVERY OF MODULES. EPOCH CORPORATION ASSUMES NO RESPONSIBILITY FOR DAMAGE INCURRED AS A RESULT TO DO SUCH.
- E. ALL FRAMING MATERIALS NEEDED FOR KNEEWALL PACKAGES AND/OR ANY OTHER REQUIRED SUPPORTS FOR SETTING OF THE MODULES. EPOCH CORPORATION PROVIDES SUGGESTED ELEVATIONS, OPENING SIZES, AND LOCATIONS FOR STANDARD KNEEWALL PACKAGES. PLEASE NOTE THAT ALL MATERIAL AMOUNTS ARE BASED ON THIS INFORMATION (SEE FOUNDATION DRAWING)
- F. ALL EXTERIOR STAIRS, PLATFORMS, RAILINGS, ETC. THE FIELD CONTRACTOR IS RESPONSIBLE TO ASSURE THAT ALL CONSTRUCTION MEETS OR EXCEEDS ALL GOVERNING CODES.
- G. ALL INTERIOR FINISH RAILINGS. (STAIR, BALCONY, ETC.)
- H. ALL GUTTERS, DOWNSPOUTS AND OTHER MISCELLANEOUS EXTERIOR TRIM. (IF GUTTERS, ETC. ARE TO BE INSTALLED NOTIFY EPOCH CORPORATION)

GENERAL NOTES AND RESPONSIBILITIES:

- -FOR MORE DETAILED INFORMATION, REFER TO EPOCH CORPORATION FIELD INSTALLATION GUIDE-I. ALL CHIMNEY AND/OR FIREPLACE MATERIAL INCLUDING
- MISC. FRAMING MEMBERS AND SHEETROCK REQUIRED TO FINISH WALLS LEFT OPEN FOR ACCESS TO OPENING. (NOTIFY EPOCH CORP OF REQUIRED SIZES FOR FRAMING TO BE DONE AT FACTORY)
- J. ALL BASEMENT INSULATION PER STATE AND LOCAL
- K. ALL SHEETROCK AND ACCESSORIES NEEDED TO COMPLETE OPENINGS AT MARRIAGE WALL LOCATIONS THAT ARE NOT SET UP TO BE CASED.
- 6. THE FIELD CONTRACTOR IS RESPONSIBLE TO INSTALL THE FOLLOWING FACTORY SUPPLIED ITEMS: (SEE NOTE #11)
- A. BALANCE OF SIDING NOT ABLE TO BE INSTALLED AT THE FACTORY. THIS GENERALLY INCLUDES ALL GABLE ENDS AND THE LAST ONE OR TWO ROWS AT THE FOUNDATION LEVEL.
- B. ALL SIDING ACCESSORIES AND TRIM NOT ABLE TO BE FACTORY INSTALLED. THIS GENERALLY INCLUDES ALL GABLE END FINISH TRIM, WOOD CORNERS, SKIRTBOARDS, AND METAL CORNERS AND ACCESSORIES FOR HARDBOARD
- C. ALL EXTERIOR LIGHTS.
- D. ELECTRICAL LIGHT BOXES, DOORBELL BUTTONS, AND/OR GFI PROTECTED BOXES AND OUTLETS ON ANY WALL THAT REQUIRES FIELD INSTALLED SIDING. EPOCH TO PROVIDE ANY REQUIRED WIRES TO ALL LOCATIONS.
- E. VENT PIPE EXTENSIONS AT THE ROOF LINE TO REQUIRED HEIGHT. MATERIAL IS PROVIDED TO ATTAIN A 24" DIMENSION ABOVE THE ROOF LINE. (SEE EXTERIOR ELEVATIONS)
- F. WINDOWS, SHUTTERS AND SIDING IF ORDERED FOR KNEEWALL PACKAGE.(NO AIR INFILTRATION BARRIER
- G. CUTTING AND INSTALLATION OF BASEMENT, SPLIT-ENTRY AND TRI-LEVEL STAIR SYSTEMS. EPOCH PROVIDES SUGGESTED STAIR DETAILS BASED ON SUGGESTED FOUNDATION HEIGHTS. ALL OPENINGS ARE FRAMED BASED ON THIS INFORMATION. THE DEALER IS REQUIRED TO NOTIFY EPOCH OF ANY CHANGES TWO WEEKS PRIOR TO THE START OF CONSTRUCTION AND/OR ADJUST RISER AND TREAD DIMENSION FOR CHANGES AND TO COMPLY WITH ALL GOVERNING CODES.
- H. FINAL INSTALLATION OF GABLE END DOORS. THE DOORS ARE TEMPORARILY NAILED AT THE FACTORY TO PREVENT WRACKING DURING TRANSPORTATION AND SETTING.
- I. INTERIOR CASED OPENINGS, DOOR PACKAGES, METAL JAMB AND HEAD PLATES AND PLYWOOD FLOORING STRIPS AT MARRAIGE WALL LOCATIONS.
- J. INTERIOR LIGHTS NOT ABLE TO BE FACTORY INSTALLED.
- K. MISCELLANEOUS FINISH MATERIALS NOT ABLE TO BE FACTORY INSTALLED.
- L. EXTERIOR TRIM FOR OVERHANGS THAT HAVE BEEN FLIPPED UP FOR SHIPPING AND/OR SETTING PURPOSES.


- 7. EPOCH CORPORATION IS REQUIRED TO COMPLETE THE FOLLOWING AT THE TIME OF DELIVERY FOR ALL MODULES:
- A. INSTALL SILL SEALER AROUND PERIMETER BEAM OF MARRIAGE WALLS AND SET THE MODULES.
- B. INSTALL TEMPORARY SUPPORTS UNDER THE MAIN CARRYING BEAM (SEE NOTE 5D)
- C. SECURE THE MODULES TOGETHER TO INSURE THE STRUCTURAL INTEGRITY. THIS GENERALLY INCLUDES BOLTING THRU THE MAIN CARRYING BEAM AT 4'-0" CENTERS AND INSTALLING METAL TIE STRAPS IN THE ROOF
- 8. IN ADDITION TO #7, EPOCH CORPORATION IS REQUIRED TO COMPLETE THE FOLLOWING AT THE TIME OF DELIVERY FOR STANDARD TRUSSED ROOFS:
- A. LIFT AND SECURE HINGED ROOF SYSTEM.
- B. PROPERLY SET ANY OVERHANGS THAT MAY HAVE BEEN
- C. INSTALL TOP SECTION OF ROOFS AND FELT PAPER ON 28 WIDES.
- D. INSTALL THE BALANCE OF GABLE END SHEATHING ON TRUSSED ROOFS
- 9. IN ADDITION TO #7, EPOCH CORPORATION IS REQUIRED TO COMPLETE THE FOLLOWING AT THE TIME OF DELIVERY FOR STANDARD CAPE MODULES:
- A. ASSIST FIELD CONTRACTOR IN COVERING MODULES WITH PROTECTIVE WRAP. EPOCH CORPORATION ASSUMES NO RESPONSIBILTY FOR DAMAGE RESULTING FROM WEATHER.
- 10. THE FIELD CONTRACTOR IS RESPONSIBLE TO INSTALL THE FOLLOWING FACTORY SUPPLIED MATERIALS:
- A. EXTERIOR WALLS. EPOCH PROVIDES PANELIZED WALLS THAT ARE FRAMED FOR ANY REQUIRED OPENINGS AND HAVE EXTERIOR SHEATHING FACTORY APPLIED. (SEE #12)
- B. ROOF SYSTEM RAFTERS ARE PRE-CUT. COLLAR TIES, RIDGE POLE, ROOF SHEATHING, FELT PAPER, SHINGLES, DRIP EDGE, AND FINISH TRIM ARE SUPPLIED. (NOTE: FACTORY SUPPLIES AIR INFILTRATION BARRIER WHEN REQUIRED)
- C. ALL SIDING FOR SECOND FLOOR AND BALANCE OF SIDING NOT ABLE TO BE COMPLETED AT THE FACTORY.
- D. ALL STANDARD AND/OR OPTIONAL WINDOWS AND
- II. THE FOLLOWING NOTES ARE INTENDED TO FURTHER CLARIFY RESPONSIBILITY FOR CAPES, GAMBRELS, AND THREE BOX MODULES:

- A. ALL ROUGH AND FINISH MATERIALS NEEDED TO COMPLETE ANY INTERIOR WORK FOR THE SECOND FLOOR.
- B. BALANCE OF MATERIALS NEEDED TO COMPLETE ELECTRICAL SYSTEM. EPOCH PROVIDES ALL REQUIRED DIRECT FEED WIRES TO PANEL WHICH ARE GENERALLY COILED TOGETHER ON THE SECOND FLOOR.
- C. BALANCE OF MATERIAL NEEDED TO COMPLETE THE PLUMBING SYSTEM. EPOCH PROVIDES MATERIAL NECESSARY TO COMPLETE FIRST FLOOR ONLY. (SEE PLUMBING DRAWING FOR FURTHER DETAILS)
- 12. EPOCH CORPORATION PROVIDES A PANELIZED WALL PLAN FOR THE SECOND FLOOR WITH A CROSS SECTION AND DETAILS TO INSURE PROPER SETTING OF FACTORY SUPPLIED PARTS. (SEE SHIPPING ENVELOPE)
- 13. THE FOLLOWING NOTES ARE INTENDED TO FURTHER CLARIFY RESPONSIBILITY ON FOUR MODULE BUILDINGS:
- A. COMPLETE ALL PLUMBING CONNECTIONS BETWEEN FLOORS WITH MATERIALS SUPPLIED BY EPOCH.
- B. COMPLETE ALL ELECTRICAL CONNECTIONS BETWEEN FLOORS AND BETWEEN SECOND FLOOR MODULES. THAT GENERALLY CONSISTS OF PLUGGING WIRES TOGETHER THAT ARE SUPPLIED WITH U/L APPROVED AMP CONNECTORS.
- C. CABLE AND PHONE WIRES ENOUGH WIRE HAS BEEN SUPPLIED TO DROP DOWN FROM UPPER FLOORS TO BASEMENT THROUGH CONDUIT LOCATED IN PLUMBING AREA OF FIRST FLOOR.
- D. SHEETROCK CEILINGS THAT MUST BE LEFT OUT FOR PLUMBING CONNECTIONS WILL BE FINISHED ON SITE BY FIELD CONTRACTOR. ALL MATERIALS FOR SHEETROCKED CEILINGS WILL BE SUPPLIED AND INSTALLED BY FIELD CONTRACTOR.
- E. IT IS THE CUSTOMER'S RESPONSIBILITY TO NOTIFY EPOCH OF DESIRED HEIGHT OF SLOPED STAIR WALLS. IF EPOCH RECEIVES NO NOTIFICATION, WALLS WILL BE HANDRAIL HEIGHT.
- 4. ALL FIELD CONNECTIONS (INCLUDING ALL STRUCTURAL, PLUMBING, MECHANICAL, AND ELECTRICAL) ARE UNDER THE JURISDICTION OF THE LOCAL BUILDING OFFICIAL.
- 15. ANY AND ALL ALTERATIONS OR MODIFICATIONS TO THE BUILDING IS THE RESPONSIBILITY OF THE BUILDER/DEALER. ALL WORK DONE ON SITE IS UNDER THE JURISDICTION OF THE LOCAL BUILDING OFFICIAL





P.O. BOX 235 SHEET TITLE: PEMBROKE, N.H. 03275 GENERAL NOTES 1-877-GO-EPOCH | GENERAL (603) 225-3907 FOR ALL FAX: (603) 225-8329 DRAWN BY: ML DATE: 5/28/13 www.epochhomes.com | SCALE: N.T.S.

SHEET NUMBER:

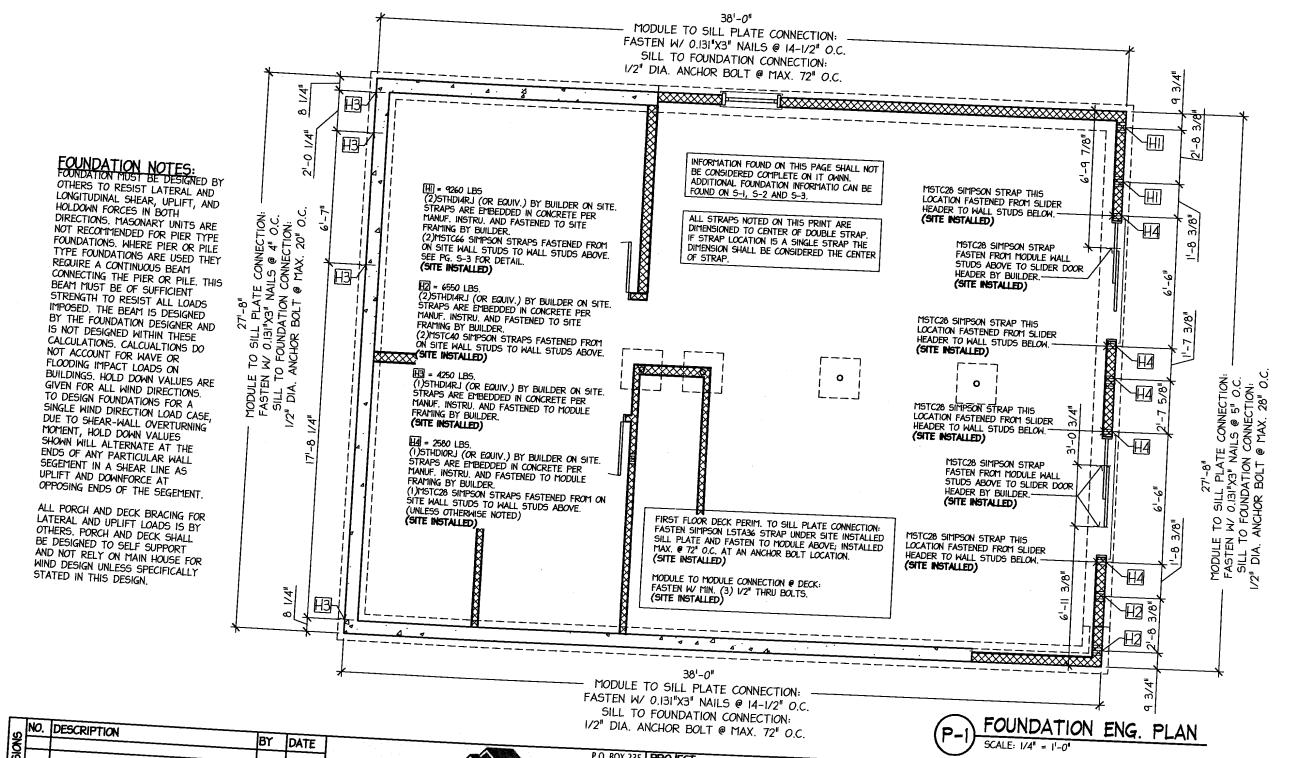

NO. DESCRIPTION BY DATE	SILL TO FOUNDATION CONNECTION: 1/2" DIA. ANCHOR BOLT @ MAX. 72" O.0	$e^{-\frac{1}{2}}$	DUNDATION ENG. PLAN ALE: 1/4" = 1'-0"
Epoch 1011 Control of time custom modular homes	OF GOOD EDUCIT HOMES 1 I VOVE IV VIII VIII VIII VIII VIII VIII	HILLCROFT SPEC.	
	J EACONA, NH	LACONIA, NH SCALE	AS NOTED DATE: 8/9/13

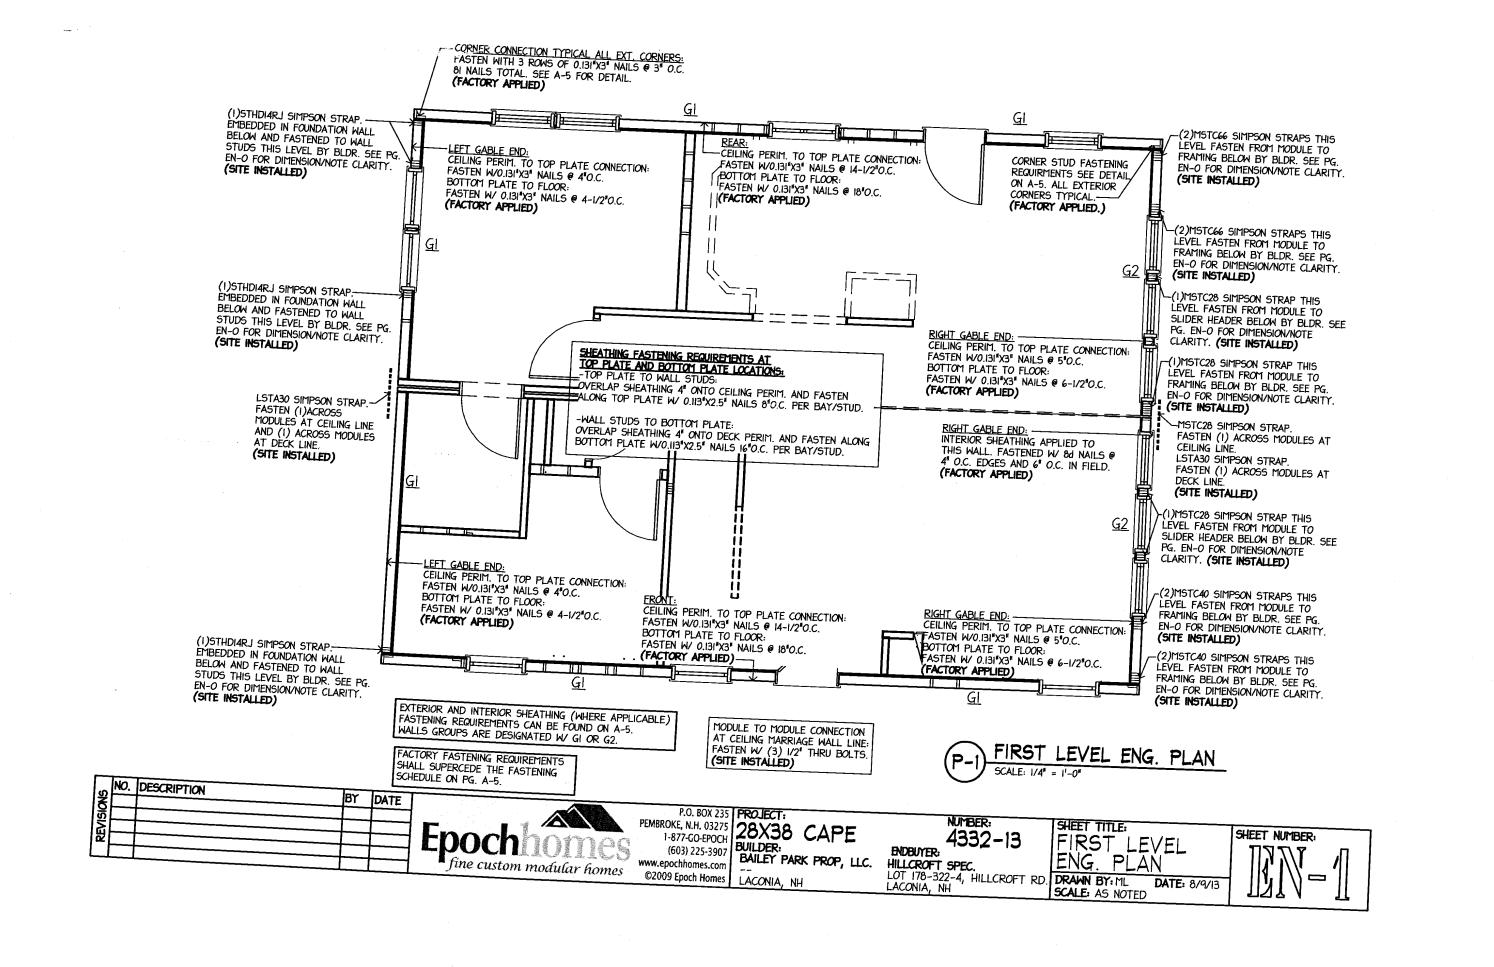

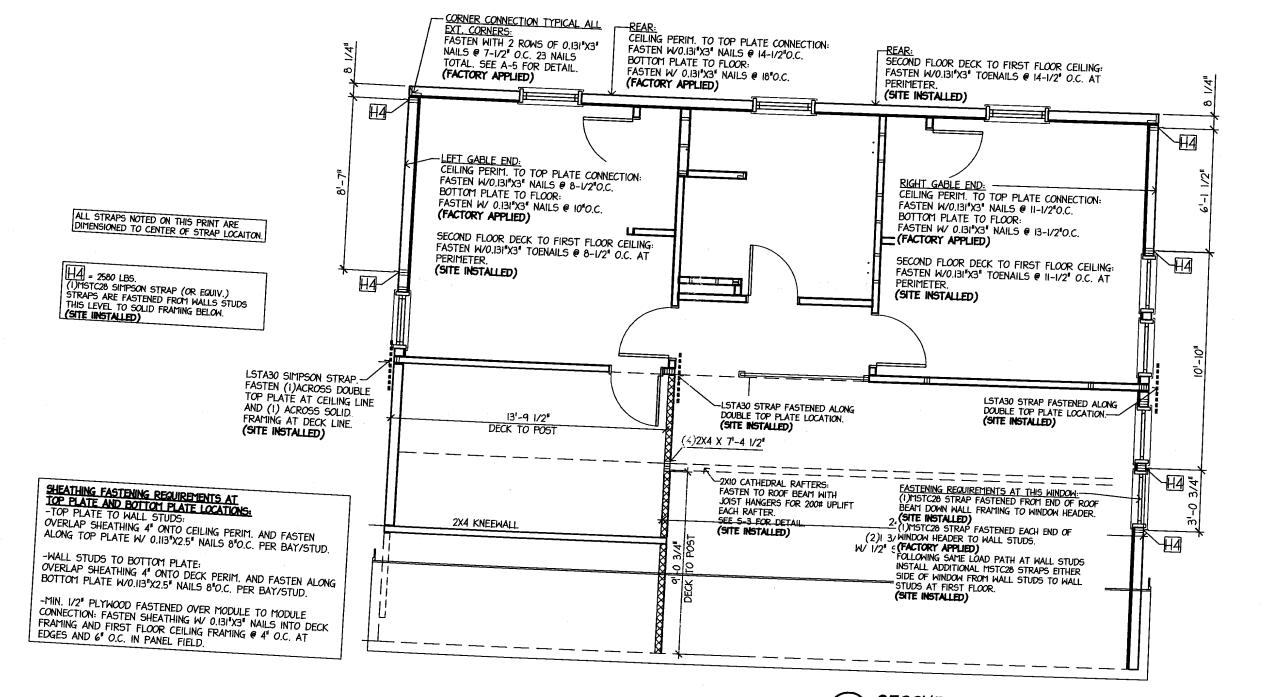

SECOND LEVEL ENG. PLAN


SCALE: 1/4" = 11-0"

NOTES:

- 1. THE FIELD CONTRACTOR IS RESPONSIBLE FOR THE STRUCTURAL DESIGN AND CONSTRUCTION OF ALL CONCRETE WORK. THIS FOUNDATION PLAN IS PROVIDED FOR DIMENSIONS AND SUGGESTED WALL HEIGHTS OMLY
- 2. THE FIELD CONTRACTOR IS RESPONSIBLE TO ASSURE THAT ALL FOOTINGS AND WALLS ARE SIZED TO MEET LOCAL AND/OR STATE CODES AND THAT ALL FOOTINGS ARE PLACED BELOW FROST LINE ON UNDISTURBED SOIL,
- 3. THE FIELD CONTRACTOR IS RESPONSIBLE TO PROVIDE THE PROPER AMOUNT OF NATURAL LIGHT AND VENTILATION IN THE BASEMENT OR CRAIL SPACE PER LOCAL AND VOR STATE CODES. HE IS ALSO RESPONSIBLE TO ASSURE THAT THE OPENINGS DO NOT INTERFERE MITH ANY OTHER REQUIRED OPENINGS; (PLUMBING, ENTRANCES, SERVICE LOCATION, ETC.)
- 4. THE FIELD CONTRACTOR OR DEALER IS TO INSTALL SMOKE DETECTORS IN THE BASEMENT.
- 5. ALL STAIR OPENINGS ARE FRAMED BASED ON FOUNDATION HEIGHTS SHOWN ON THIS PLAN.
- 6. ANY OPENINGS IN THE FOUNDATION WALL ARE TO HAVE PROPERLY SIZED HEADERS. DETERMINATION OF HEADER SIZES IS THE SOLE RESPONSIBILITY OF THE CUSTOMER.

7. # - DIMENSIONS ARE APPROXIMATE.

- 8. THE FIELD CONTRACTOR IS TO NOTIFY EPOCH CORPORATION WHEN THE FOUNDATION, SILL, KNEEWALLS AND/OR ANY OTHER REQUIRED CONSTRUCTION ARE READY FOR SETTING OF THE MODULES. HIS NOTIFICATION ASSERS FROM CORP. THAT THE SILLE ASSURES EPOCH CORP. THAT THE SILLS
 AND/OR OTHER REQUIRED CONSTRUCTION ARE
 SQUARE AND LEVEL AND MEET ALL LOCAL
 AND/OR STATE CODES.
- 9. THE FIELD CONTRACTOR IS RESPONSIBLE
 TO INSTALL PERMANENT LALLY COLUMNS A
 MAXIMUM OF 3 DAYS AFTER MODULES ARE
 SET. EPOCH CORPORATION ASSUMES NO
 RESPONSIBILITY OF DAMAGE FOR FAILURE
 TO DO SO
- IO. THE FIELD CONTRACTOR IS RESPONSIBLE TO INSTALL AND SUPPLY A 2% W/ 1/2" SHIM ON TOP OF THE FOUNDATION SILL IN THE EVENT THAT THERE IS A JOG IN THE FOUNDATION.
- II. LALLY COLUMN FOOTINGS TO BE DESIGNED BY OTHERS PER BUILDING, SITE SOIL CONDITIONS, AND LOCAL CODE REGUIREMENTS.

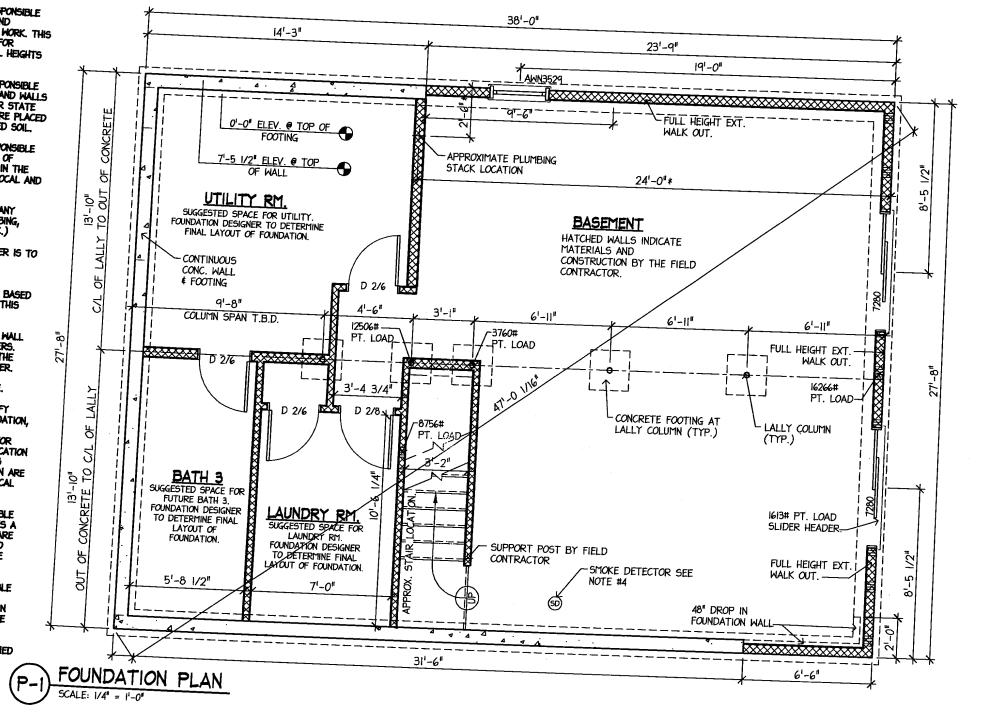

Γ	NO.	DESCRIPTION			
2	E	REV'D PER PROF DATED	BY	DATE	
	2	REV'D PER PRRF DATED 6/13/13D REV'D PER MARK-UP DATED 7/25/13D	ML	6/14/13	
1	j	1/25/13D	ML	7/25/13	Engal
"	-				EDUCH (ATACA
					fine custom modular homes

P.O. BOX 235 PROJECT: PEMBROKE, N.H. 03275 28X38 CAPE 1-877-GO-EPOCH (603) 225-3907 BUILDER: BAILEY PARK PROP, LLC. www.epochhomes.com 247 HAYDEN RD. ©2009 Epoch Homes HOLLIS, NH 03049


NUMBER: 4332-13 ENDBUYER:

HILLCROFT SPEC. LOT 178-322-4, HILLCROFT LACONIA, NH 03246

SHEET TITLE: FOUNDATION PLAN

DRAWN BY: ML DATE: 6/11/13 SCALE: AS NOTED

SHEET NUMBER:

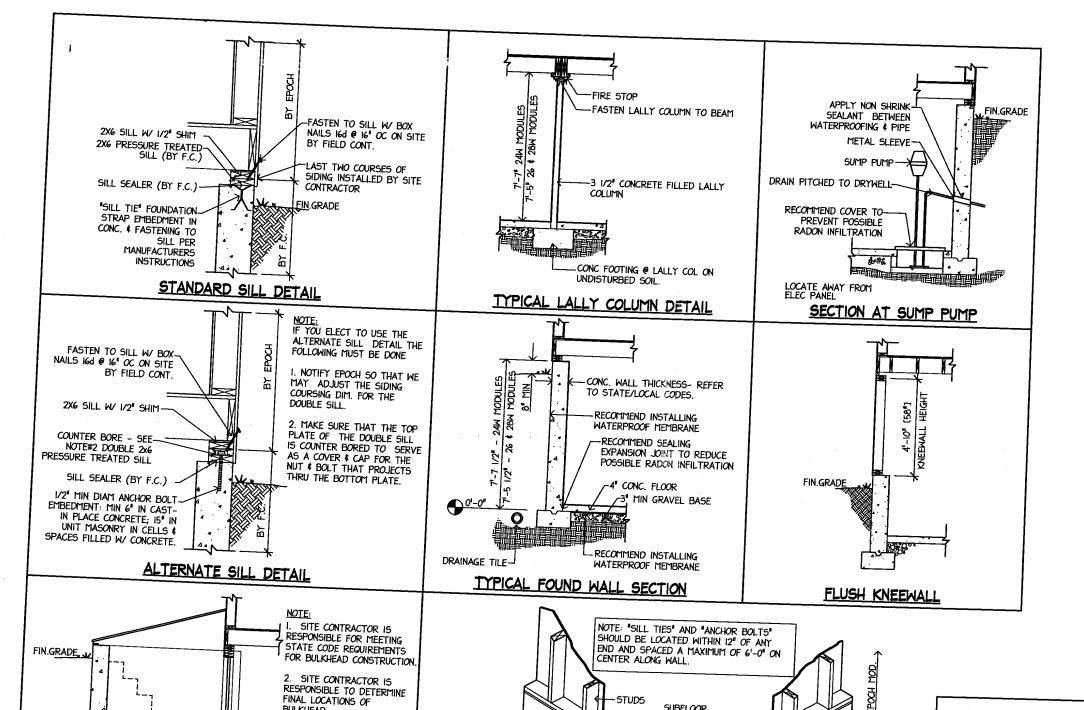

BULKHEAD

3. FIELD CONTRACTOR IS RESPONSIBLE TO DETERMINE FINAL LOCATIONS AND MEET


ALL GOVERNING CODES.


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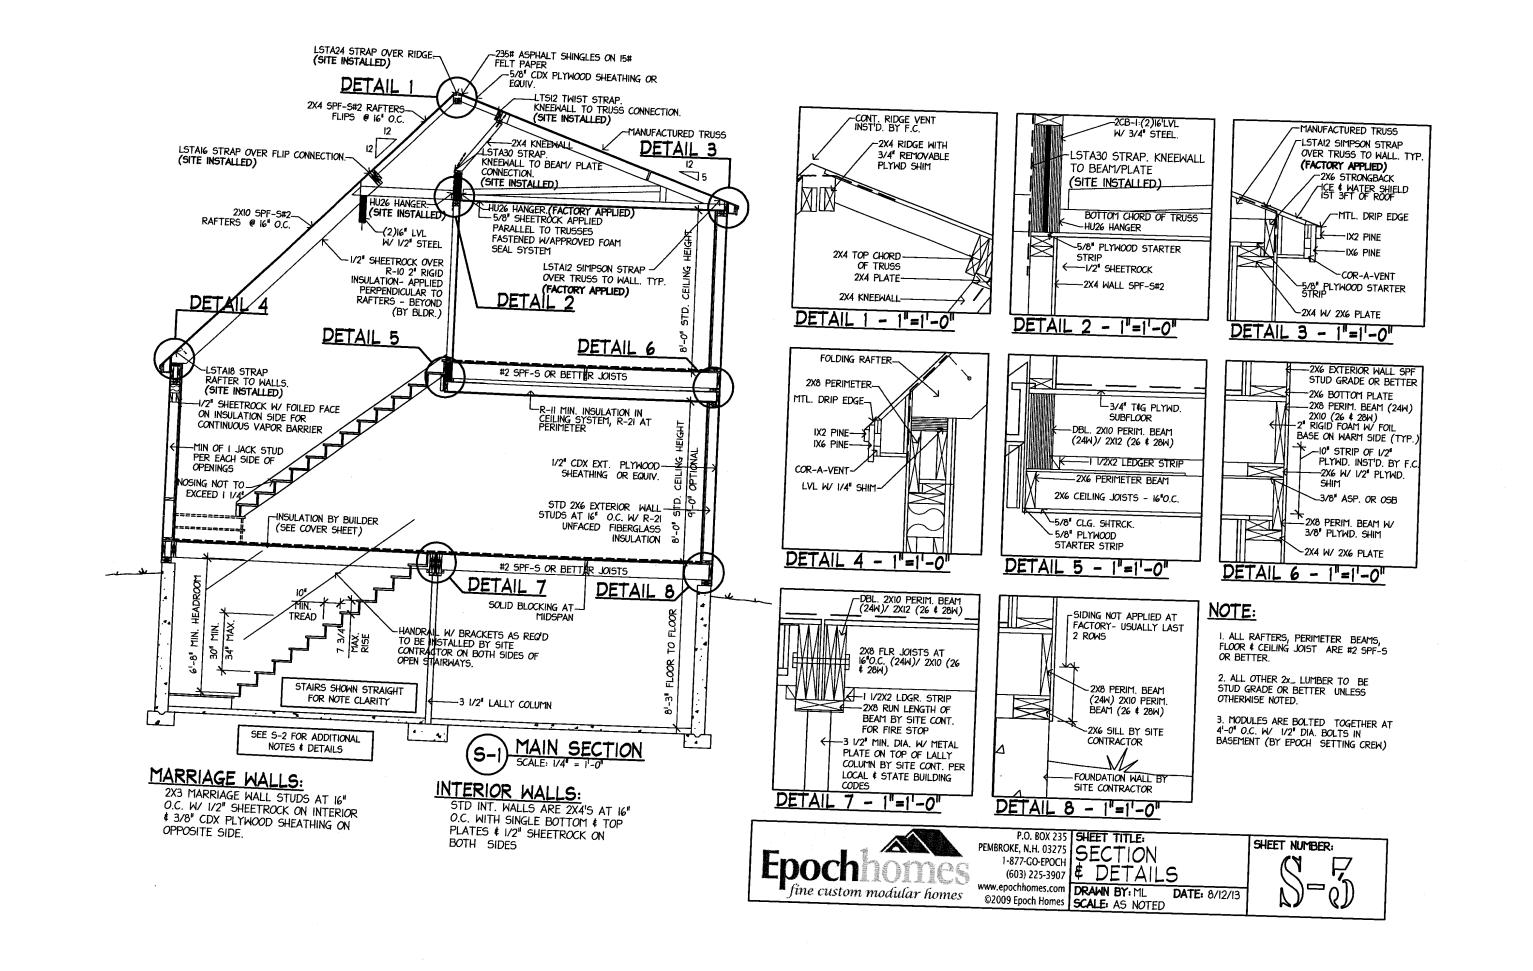
BY BUILDER L

38 808E A 380E

SECTION THRU BULKHEAD



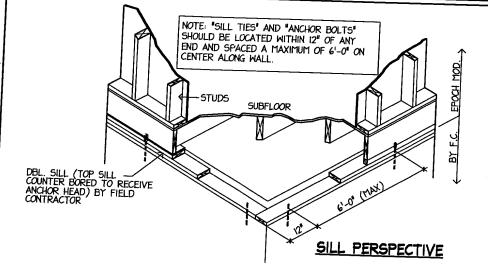

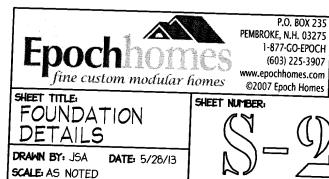


ELECTRICAL NOTES:

- I. EPOCH CORP. ASSURES THAT ALL ELECTRICAL REQUIREMENTS MEET OR EXCEED THE CURRENT NATIONAL ELECTRIC CODE, ALL ELEMENTS ARE "U.L" APPROVED AND ALL ELECTRICAL MORK HAS
- 2. THE FIELD CONTRACTOR IS REQUIRED TO MAKE ALL FINAL ELECTRICAL CONNECTIONS TO THE PANEL, AND OTHER CONNECTIONS NOT POSSIBLE TO BE COMPLETED AT THE FACTORY, ALL WIRES WILL BE PLAINLY MARKED AND PROVIDED WITH CONNECTORS WHERE POSSIBLE.
- 3. HEATING ELEMENTS ARE SIZED TO BE 10%-15% ABOVE THE REQUIRED CALCULATED HEAT LOSS AND ARE RATED AT 250 WATTS PER FOOT. THE MAXIMUM AMOUNT OF WATTAGE PER CIRCUIT IS
- 4. ALL PANELS ARE PROVIDED WITH PROPER SIZED CIRCUIT BREAKERS FOR THE NUMBER OF FACTORY INSTALLED CIRCUITS. THE ELECTRICAL CONTRACTOR IS RESPONSIBLE TO PROVIDE AND
- 5. THE DEALER IS RESPONSIBLE TO NOTIFY EPOCH CORP. OF SIZE AND EXACT LOCATION OF SPECIAL ELECTRIC REQUIREMENTS (MICROWAVE OVENS, SPECIAL APPLIANCES, ETC.) BEFORE
- 6. ALL BATH, KITCHEN COUNTER, AND EXTERIOR OUTLETS ARE PROTECTED BY A GROUND FAULT
- 7. SEE GENERAL SPECIFICATIONS SHEET FOR ADDITIONAL INFORMATION.
- 8. ALL WIRING IS TYPE N/M COPPER UNLESS SPECIFIED.
- 9. RANGE CABLE IS 4-PRONG, 8-3 COPPER WITH GROUND.
- 10. ELECTRICAL REQUIREMENTS MEET OR EXCEED MASS SUPPLEMENTARY ELECTRICAL CODE.
- II. RANGE FANS ARE DUCTED THRU THE EXTERIOR WALL INTERIOR WALL LOCATIONS ARE FIGURED
- 12. BATH FAN/LIGHT COMBINATIONS ARE VENTED TO THE EXTERIOR.
- 13. ALL REQUIRED PHOTOELECTRIC SMOKE DETECTORS, CO AND HEAT DETECTORS ARE CONNECTED AND MIRED AS A TYPE III SYSTEM. SMOKE DETECTOR(S) ON THE IST FLOOR ARE MIRED AND INSTALLED BY FIELD CONTRACTOR ON SITE @ LOCATIONS TO BE DETERMINED BY THE LOCAL FIRE MARSHALL (MIRING PROVIDED AT FACTORY). BEGEDMAGIEURY OF THE LOCAL FIRE MARSHALL (MIRING PROVIDED AT FACTORY).
- 14. ALL FACTORY PROVIDED SMOKE DETECTORS ARE AC/DC WITH BATTERY BACK-UP.
- 15. BUILDINGS GOVERNED BY THE 2011 NEC CODE ARE REQUIRED TO HAVE AFCI PROTECTION ON ALL BA AND 20A 120V BRANCH CIRCUITS SUPPLYING OUTLETS IN ALL LIVING AREAS AS WELL AS CLOSETS, HALLS AND SIMILAR AREAS. (DEDICATED APPLIANCE CIRCUITS, MEANING DISHMASHER,
- 16. BUILDINGS GOVERNED BY THE 2011 NEC CODE ARE REQUIRED TO HAVE TAMPER RESISTANT
- 17. BUILDINGS GOVERNED BY THE 2011 NEC CODE ARE REQUIRED TO HAVE A SPARE NEUTRAL CONDUCTOR AT ALL SMITCHES THAT CONTROL LIGHTING LOADS.

PLUMBING AND HOT WATER HEAT NOTES:

- I. STANDARD PLUMBING SYSTEMS ARE:
- a. DRAIN, MASTE, AND VENT PIPES ARE PVC SCH 40. THE MAIN STACK IS 3".
- b. DISTRIBUTION LINES ARE 1/2" OR 3/4" TYPE "L" COPPER OR PEX. THE DEALER IS RESPONSIBLE TO NOTIFY EPOCH OF ANY SPECIAL PLUMBING LOCATIONS OR REQUIREMENTS BEFORE
- 2. ALL PLUMBING DRAINS ARE STUBBED THRU THE FLOOR. THE PLUMBING CONTRACTOR IS RESPONSIBLE TO INSTALL SHUTOFF VALVES AND COMPLETE THE PLUMBING SYSTEM, MEETING OR
- 3. THE PLUMBING CONTRACTOR IS RESPONSIBLE TO MAKE ALL FINAL CONNECTIONS NOT POSSIBLE AT THE FACTORY AND TO EXTEND ALL 3' VENT PIPES ABOVE THE ROOF LINE TO MEET OR
- 4. EPOCH CORP. ASSURES THAT ALL FACTORY INSTALLED PLUMBING HAS BEEN AIR TESTED AND APPROVED. THE TESTS ARE AS FOLLOWS: a. DISTRIBUTION LINES ARE PRESSURIZED AT 125 PSI HELD FOR 15 MINUTES.
- b. PVC LINES ARE PRESSURIZED AT 6 PSI AND HELD FOR 15 MINUTES.
- 5. EPOCH CORP. PLUMBING SYSTEMS MEET OR EXCEED THE BOCA PLUMBING CODE.
- 6. HEATING ELEMENTS ARE SIZED TO BE 10%-15% ABOVE THE REQUIRED CALCULATED HEAT LOSS AND ARE RATED AT 600 BTU'S PER FOOT OF FINNED LENGTH, CALCULATIONS ARE BASED ON ASSUMED WATER TEMPERATURE OF 1856F.
- 7. THE PLUMBING CONTRACTOR IS RESPONSIBLE TO SUPPLY AND INSTALL ALL BOILER SHITCHES, THERMOSTATS, AND WIRING FOR THE SAME. HE IS ALSO RESPONSIBLE TO DETERMINE ALL
- 8. THE HEATING COPPER FEED LINE ARE TO BE TYPE "TY" OR PEX AND STUBBED THRU THE FLOOR AT EACH END OF THE INDIVIDUAL UNITS. THE PLUMBING CONTRACTOR IS RESPONSIBLE TO COMPLETE THE HEATING SYSTEM, MEETING OR EXCEEDING GOVERNING CODES.
- 9. KITCHEN SINKS ARE EQUIPPED WITH A SHUTOFF VALVE AND 30' SUPPLY LINE DROPPED THRU
- 10. BATH LAV'S, ARE EQUIPPED WITH A SHUTOFF VALVE AND A 24" SUPPLY LINE DROPPED THRU
- II. ---- CONNECTIONS TO BE MADE BY FIELD CONTRACTOR UNDER THE FLOOR OR IN THE
- 12. CONTRACTOR IS RESPONSIBLE TO FURNISH AND INSTALL THE HOT WATER HEATER, MEETING OR EXCEEDING GOVERNING CODES.
- 13. CONTROL VALVES ARE INSTALLED AND CONFORM TO LOCAL CODES,
- M. CONTRACTOR IS RESPONSIBLE TO EQUIP. EXT. HOSE SUPPLY WITH A VACUUM BREAKER AND INSTALL AS PER LOCAL GOVERNING CODES.
- 15. WATER SUPPLY SYSTEM BELOW FIRST FLOOR IS SUGGESTED ONLY ALL WORK IS TO BE DONE ON SITE BY GEN'L CONTRACTOR, USING APPROVED MAT'LS. - PER APPLICABLE CODES.
- 16. PLUMBING CONTRACTOR IS TO CONNECT ALL DRAINS BELOW FLOOR COMPLETING SYSTEM TO MAIN HOUSE DRAIN PER APPLICABLE CODES. INSTALLING CLEAN OUTS AS REQUIRED.
- 17. ALL SOLDER JOINTS TO BE DONE WITH 95-5 LEAD FREE SOLDER.
- 18. ALL VERTICAL PVC DWV LINES TO BE SUPPORTED AT A MINIMUM OF 4'-0". EPOCH CORP. TO USE PLASTIC STRIP ATTACHED TO PIPE & FASTENED TO STUD.

NO. DESCRIPTION BY DATE P.O. BOX 235 PEMBROKE, N.H. 03275 1-877-G0-EPOCH Fine custom modular homes P.O. BOX 235 PEMBROKE, N.H. 03275 1-877-G0-EPOCH Www.epochhomes.com ©2009 Epoch Homes P.O. BOX 235 PROJECT: 28X38 CAPE BVILDER: BNDBUYER: BNDBUYER: BNDBUYER: BAILEY PARK PROP, LLC. LOT 178-322-4, HILLCROFT RD DRAWN BY: SPC DATE: 1/31/II LACONIA, NH SCALE: NO SCALE SHEET NUMBER: LACONIA, NH SHEET NUMBER: LACONIA, NH SHEET NUMBER: LACONIA, NH SCALE: NO SCALE]
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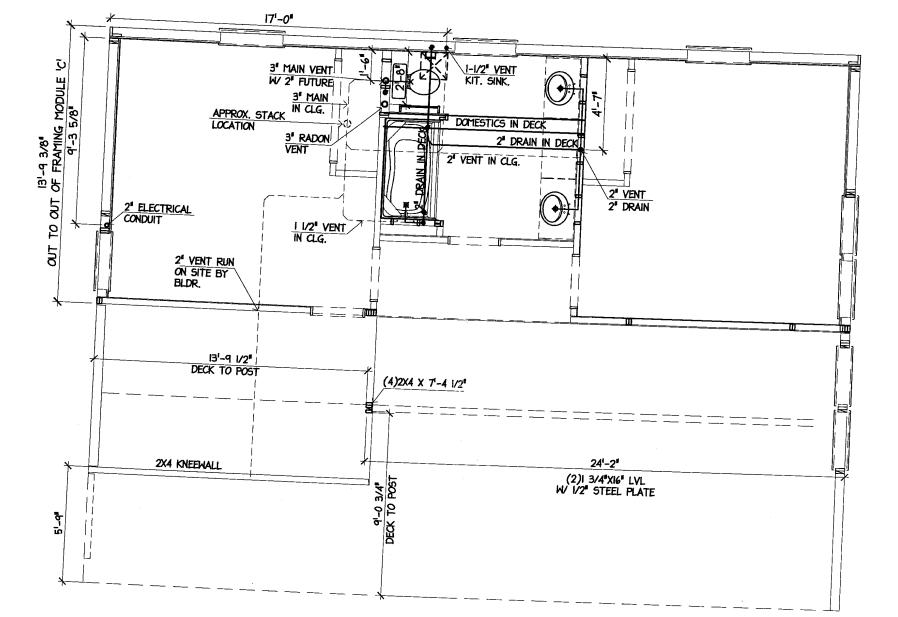


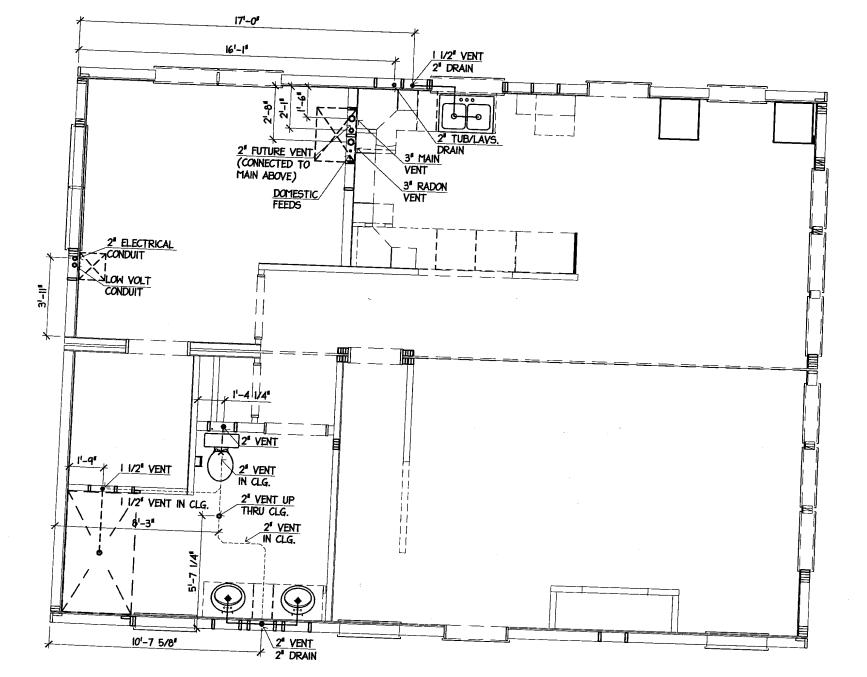PLUMBING AND HOT WATER HEAT NOTES:

I. SEE M-I FOR PLUMBING AND HOT WATER HEAT NOTES.



NO. DESCRIPTION BY DATE P.O. BOX 235 PEMBROKE, N.H. 03275 1-877-CO-EPOCH (603) 225-3907 Www.eprchhomes.com ©2009 Epoch Homes PROJECT: 28X38 CAPE BUILDER: HILLCROFT SPEC. LOT 178-322-4, HILLCROFT RD DRAWN BY: ML DATE: 8/24/13 HOLLIS, NH 03049 NUMBER: FIRST LEVEL PLUMBING LACONIA, NH 03246 SCALE: AS NOTED SHEET TITLE: FIRST LEVEL PLUMBING LACONIA, NH 03246 SCALE: AS NOTED	
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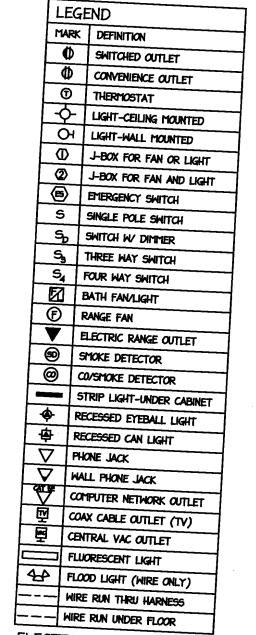


PLUMBING AND HOT WATER HEAT NOTES:

I. SEE M-I FOR PLUMBING AND HOT WATER HEAT NOTES.




NO. DESCRIPTION I ADDED VENT PIPE ML 8/21/13 EPOCH 10 16 603) 225-3907 www.epochhomes.com @2009 Epoch Homes P.O. BOX 235 PROJECT: 28X38 CAPE BNDBUTER: BAILEY PARK PROP, LLC. LOT 178-322-4, HILLCROFT RD. DRAWN BY: ML DATE: 8/21/13 DRAWN BY: ML DATE: 8/21/13 SHEET NUMBER: BAILEY PARK PROP, LLC. LOT 178-322-4, HILLCROFT RD. DRAWN BY: ML DATE: 8/21/13 DRAWN BY: ML DATE: 8/21/13 DRAWN BY: ML DATE: 8/21/13 DRAWN BY: ML DATE: 8/21/13	
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ELECTRICAL NOTES:

1. SEE M-I FOR ELECTRICAL NOTES.



NO. DESCRIPTION						
8	BY DATE		P.O. BOX 235 PROJECT :			
REVIS			PEMBROKE, N.H. 03275 28X38 CAPE	NUMBER:	SHEET TITLE:	GUEET NUMBER
ăZ		Lpoch mes	(603) 225-3907 BUILDER:	ENDBUYER: 4332-13	FIRST LEVEL	SHEET NUMBER:
		fine custom modular form	www.epochhomes.com	HILLCROFT SPEC	ELECTRICAL	
			©2009 Epoch Homes HOLLIS, NH 03049	LOT 178-322-4, HILLCROFT R LACONIA, NH 03246	DRAWN BY: ML DATE: 7/25/13 SCALE: AS NOTED	7 111/1 1
					TSCALES AS NOTED	12 1

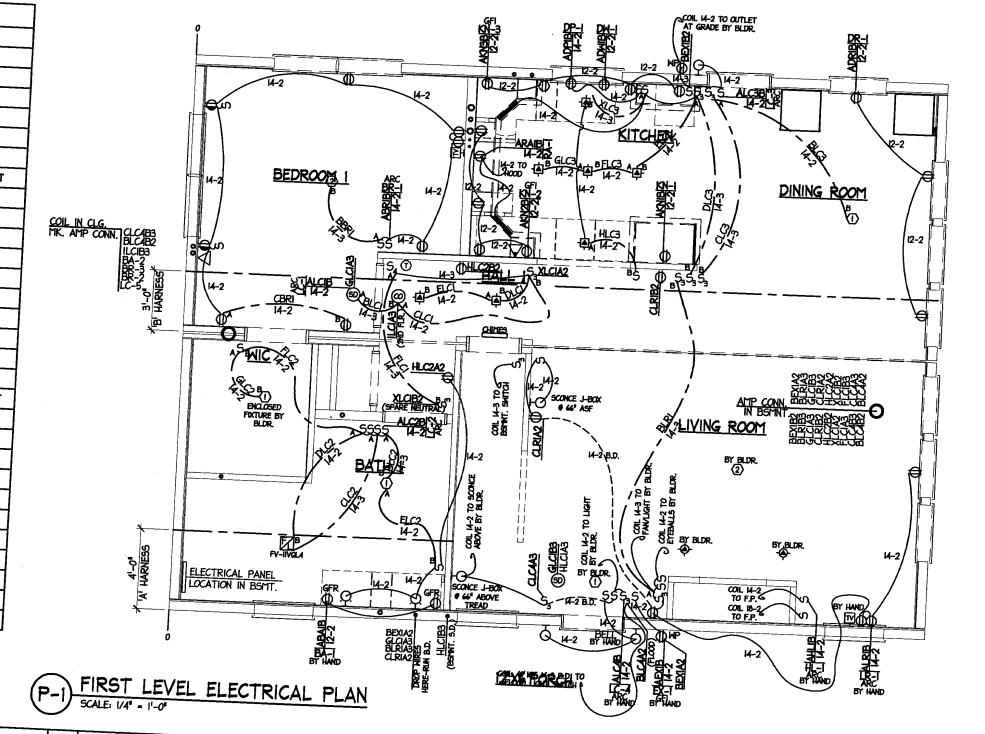SITE PREPARATION NOTES:

I. SILL MUST BE INSTALLED BY THE CUSTOMER. SILL SHALL BE LEVEL, SQUARED, AND STRAIGHT. SILL SHALL BE ANCHORED TO THE FOUNDATION AND THERE SHALL BE NO PROTRUSIONS OR OBSTRUCTIONS ABOVE THE SILL. WHERE SHIMMING IS REQUIRED, SHIMS SHALL BE SOLID AND LOCATED BY MOSE TIME A READ. SHIMS SHALL BE SOLID AND LOCATED NO MORE THAN 2'-0" APART.

2. KNEEWALLS, WHEN USED, SHALL BE ALIGNED, LEVELED, AND SOLIDLY BRACED BY THE CUSTOMER. THE SILL AT THE TOP OF KNEEWALL(S) SHALL CONSIST OF A MINIMUM OF ONE(I) 2x6 TOP PLATE. THE KNEEWALL BRACING SHALL BE SUFFICIENTLY ANCHORED SO AS TO PERMIT ALIGNMENT OF THE HOUSE TO THE SILL UNDER PARTIAL LOAD, WHEN USING FOUR(4) KNEEWALLS, SEE SPECIAL KNEEWALL BRACING DETAIL SHEET.

3. ALL FORM TIES SHALL BE REMOVED.

4. THE SITE SHALL BE CLEAR OF TREES, BOULDERS AND OTHER OBSTRUCTIONS IN ORDER TO PROVIDE TWO (2) AREAS APPROX. 301/4601 FOR THE CRANE AND THE TRANSPORTERS WITH REASONABLE ACCESS TO THESE AREAS FROM THE STREET. THE TWO AREAS SHALL BE ADJACENT TO EACH OTHER WITH ONE AREA HAVING ONE OF ITS DIMENSIONS AT THE FOUNDATION. THE AREA AGAINST THE FOUNDATION (FOR CRANE) SHALL BE REASONABLY LEVEL. (SEE TYPICAL LAYOUT DRAWINGS). IF THERE IS ANY QUESTION AS TO THE ARRANGEMENT OF CLEARED AREAS, CONTACT THE SITE INSPECTOR. THE ARRANGEMENT OF CLEARED AREAS, CONTACT THE SITE INSPECTOR. THE AREAS LISTED ABOVE FOR THE CRANE AND THE TRANSPORTERS SHALL CONSIST OF UNDISTURBED EARTH OR WELL COMPACTED GRAVEL FILL UPON WHICH THE CRANE AND TRANSPORTER MAY TRAVEL AND OPERATE WITHOUT UNDSTURBED EARTH OR WELL COMPACTED GRAVEL FILL UPON WHICH THE CRANE AND TRANSPORTER MAY TRAVEL AND OPERATE WITHOUT BECOMING BOGGED DOWN AND INOPERATIVE. IF THERE IS A CHANCE OF THIS POSSIBILITY OCCURING, THE CUSTOMER SHALL HAVE A BULLDOZER OR OTHER SIMILAR EQUIPMENT TO ASSIST ENTERING AND EXITING THE SITE. THIS EQUIPMENT SHOULD ALSO BE AVAILABLE ON THE SITE WHEN THE GRADE FROM THE ROAD TO THE FOUNDATION IN THE CLEARED AREA IS IN EXCESS OF 18 INCHES IN A 18 FOOT RUN.

5. THE SITE SHALL BE REVIEWED THREE(3) TO FOUR(4) DAYS IN ADVANCE OF DELIVERY BY YOUR SALES REPRESENTATIVE WHEN REQUESTED BY BUILDERS.


6. THE DEALER IS RESPONSIBLE TO ARRANGE FOR THE TEMPORARY 6. THE DEALER IS RESPONSIBLE TO ARRANGE FOR THE LITTURARY
REMOVAL OF ALL OVERHEAD WIRES THAT ARE WITHIN 12'-0" OF WHERE
THE CRANE OR HOUSE WILL BE LOCATED FOR SETTING. IF THERE IS A QUESTION AS TO WHETHER OR NOT A WIRE IS GOING TO BE A PROBLEM, PLEASE CONTACT EPOCH'S TRANSPORTATION DEPARTMENT. ANY COST INCURRED BY EPOCH DUE TO THE FAILURE OF HAVING WIRES REMOVED SHALL BE CHARGED TO THE DEALER.


7. THE ENTRANCE TO THE SITE FROM THE ROAD SHALL BE A MINIMUM OF 20'-0" WIDE AND CONSIST OF UNDISTURBED EARTH OR WELL COMPACTED GRAVEL FILL. THE ENTRY AT THE ROAD ITSELF SHALL HAVE A RADIUS CLEARED OF BOULDERS AND TREES AND CONSIST OF SOIL AND FILL AS PREVIOUSLY DESCRIBED. THE RADIUS SHALL COMPLY WITH THE FOLLOWING


PAVED ROAD OVER 40'-0" WIDE USE A MIN. 6'-0" R. PAVED ROAD 30' - 40' WIDE USE A MIN. IO'-O' R. PAVED ROAD 24' - 30' WIDE USE A MIN. 20'-0' R. PAVED ROAD UNDER 24' MIDE USE A MIN. 30'-0' R.


8. THE DEALER IS RESPONSIBLE TO PROVIDE EPOCH HOMES WITH ACCURATE DIRECTIONS TO THE SITE. THE DIRECTIONS MUST BE COMPLETE WITH STREET NAMES, DISTANCES, AND ANY LANDMARKS
THAT WILL HELP FIND THE SITE, PLEASE NOTE ANY POSSIBLE TROUBLE AREAS SUCH AS ROAD CONSTRUCTION, BRIDGES WITH WEIGHT RESTRICTIONS, UNMARKED ROADS, ETC.


9. ALL OF THE ABOVE REQUIREMENTS MUST BE MET OR THE CUSTOMER IS SUBJECT TO ADDITIONAL CHARGES.

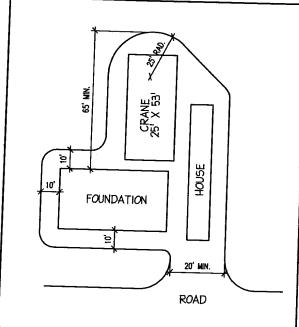


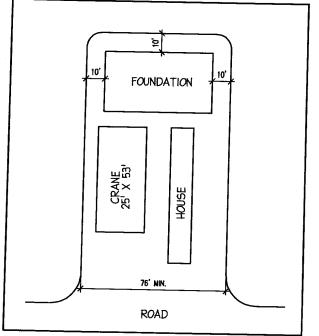

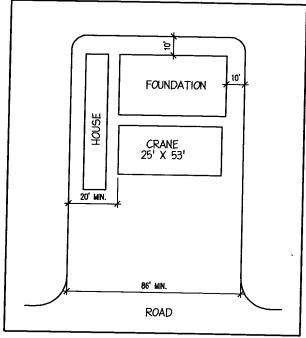

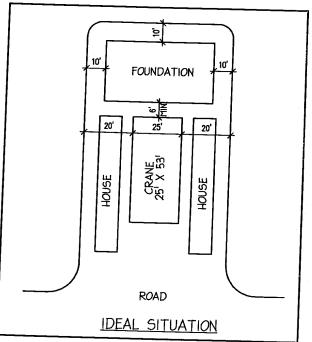

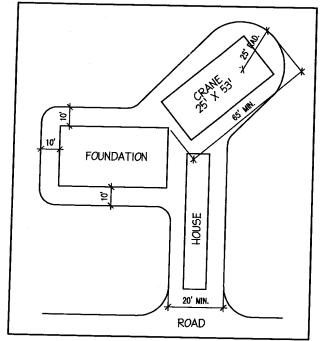

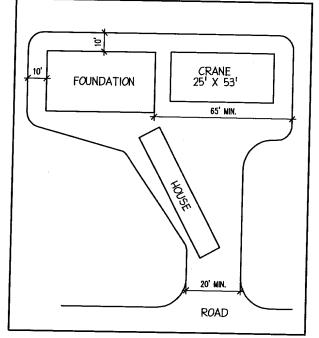



P.O. BOX 235 SHEET TITLE: PEMBROKE, N.H. 03275 1-877-GO-EPOCH (603) 225-3907 FOR ALL HOUSES FAX: (603) 225-8329 **DRAWN BY:** JSA

DATE: 5/28/02 SCALE: N.T.S.

